


SE 3RD STREET SIDEWALK

05/15/2024

CITY OF LINCOLN CITY, OREGON

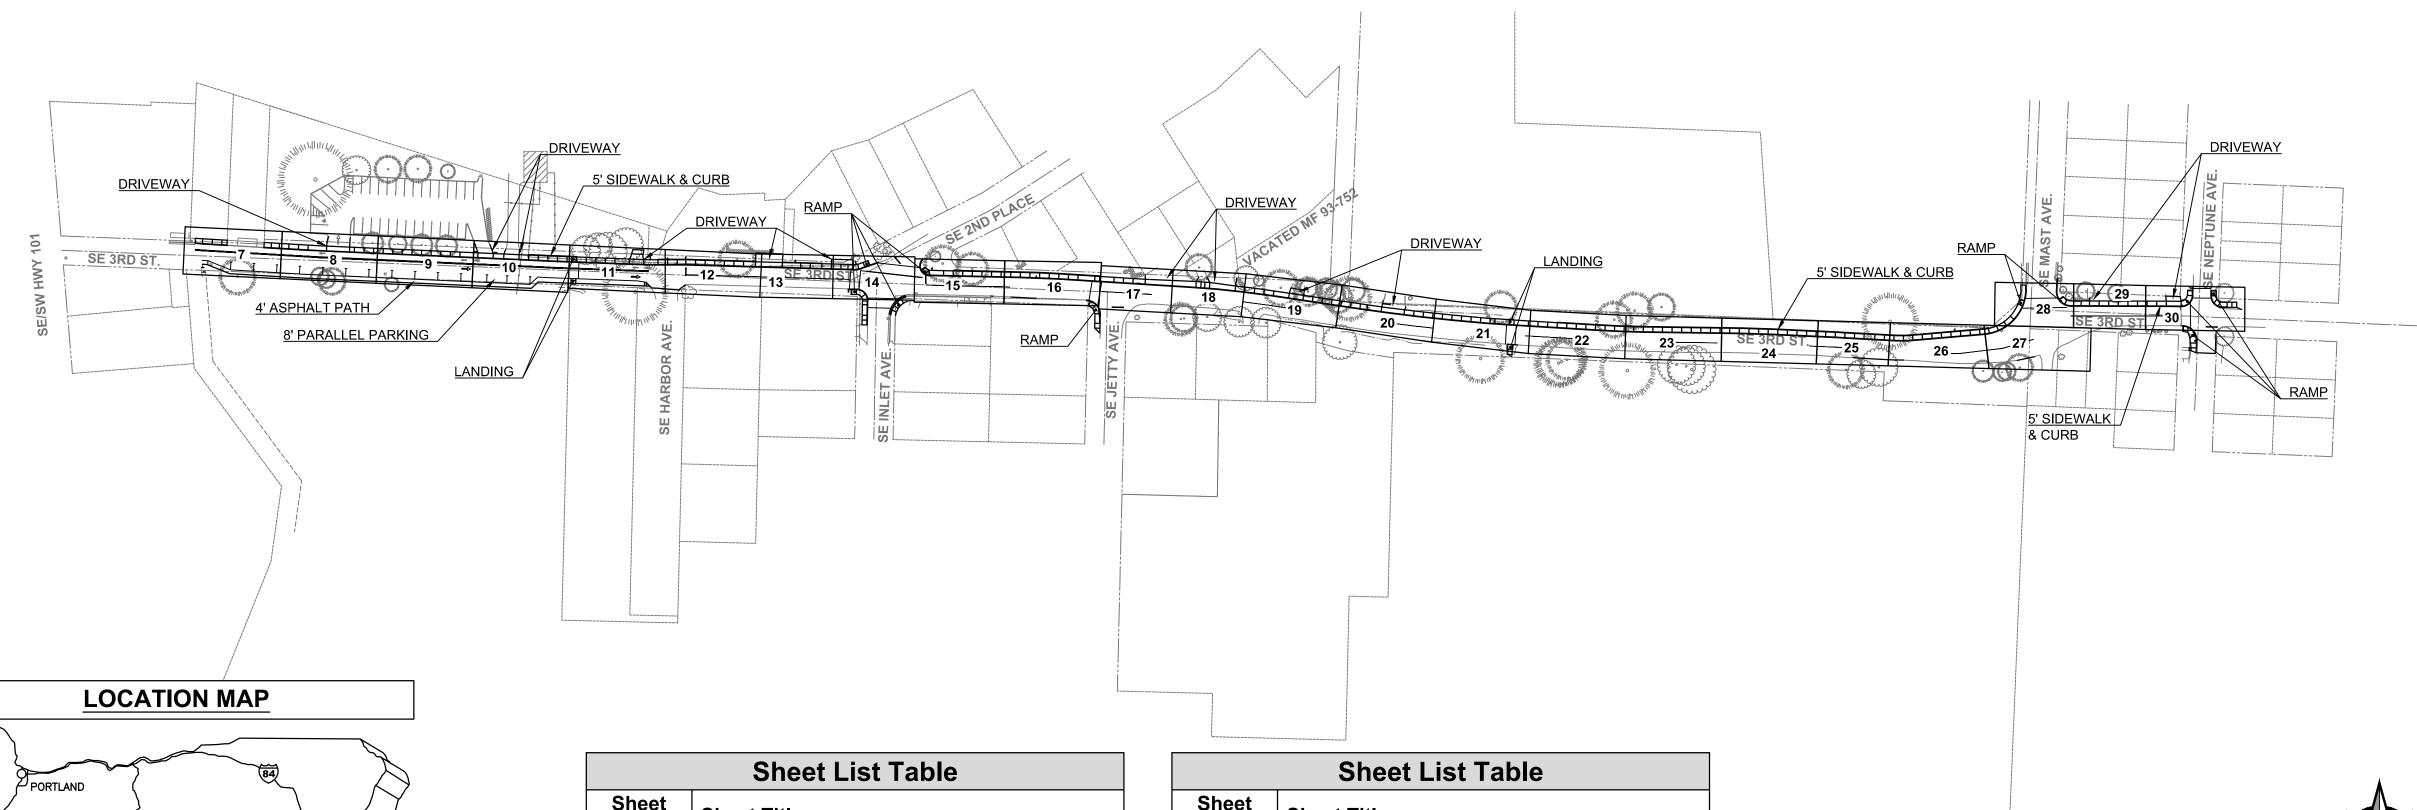

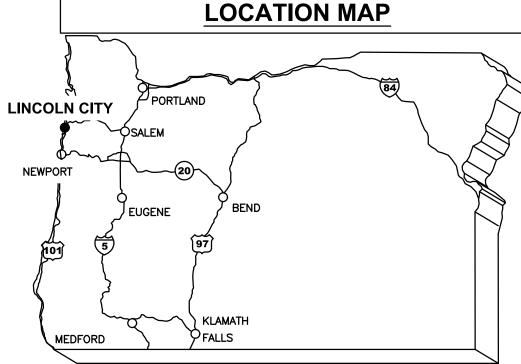

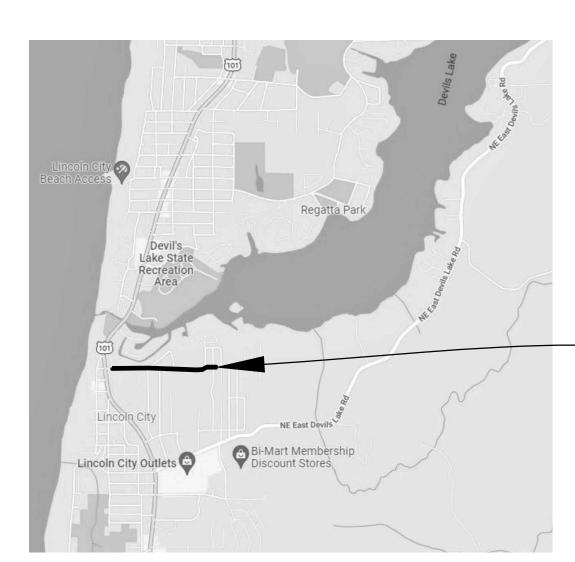

.PROJECT


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STORM AND PAVING PLAN & PROFILE (16+50 TO 17+50)

STREET AND UTILITY PLAN & PROFILE (STA 17+50 TO 18+50)

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GENERAL NOTES:

- 1. ALL CONSTRUCTION ACTIVITIES SHALL BE LIMITED TO THE HOURS BETWEEN 7:00 AM AND 7:00 PM, MONDAY THROUGH FRIDAY, UNLESS OTHERWISE APPROVED BY THE ENGINEER.
- 2. CONTRACTOR SHALL PROVIDE ALL APPLICABLE PUBLIC AND PRIVATE CONSTRUCTION NOTIFICATION AS DETAILED IN THE PROJECT SPECIAL PROVISIONS.
- CONTRACTOR IS RESPONSIBLE FOR MAINTAINING A CURRENT SET OF PLANS, SPECIFICATIONS
 AND SPECIAL PROVISIONS ON SITE AT ALL TIMES. CONTRACTOR IS REQUIRED TO RECORD ANY
 CONSTRUCTION DEVIATIONS TO THESE DRAWINGS AND NOTE THE LOCATION AND ELEVATION
 OF ALL EXISTING UTILITIES ENCOUNTERED.
- 4. LOCATIONS AND DESCRIPTIONS OF ALL EXISTING UTILITIES OR OTHER OBSTRUCTIONS SHOWN IN THE PROJECT PLANS ARE COMPILED FROM AVAILABLE RECORDS AN/OR FIELD SURVEYS. ACCURACY AND COMPLETENESS ARE NOT GUARANTEED; CONTRACTOR SHALL FIELD-VERIFY ALL UTILITY LOCATIONS PRIOR TO CONSTRUCTION.
- 5. CONTRACTOR SHALL BE RESPONSIBLE FOR ANY DAMAGE THAT OCCURS TO ASPHALT PAVEMENT, CONCRETE PAVEMENT, CONCRETE STRUCTURES, BUILDINGS, VALVE AND/OR METER BOXES, SIGNS, ETC. DUE TO CONSTRUCTION ACTIVITIES.
- 6. NO OPEN EXCAVATION TO BE LEFT DURING CONSTRUCTION OFF HOURS. ALL OPEN CUTS OF EXISTING STREETS AND DRIVEWAYS TO BE BACKFILLED TO GRADE, PATCHED WITH A HOT OR COLD AC MIX, OR COVERED WITH A STEEL PLATE.
- 7. PRIOR TO BEGINNING WORK, THE EROSION CONTROL PLAN MUST BE APPROVED BY THE CITY. EFFECTIVE EROSION CONTROL IS REQUIRED. EROSION CONTROL DEVICES MUST BE INSTALLED AND MAINTAINED MEETING CITY AND D.E.Q. REQUIREMENTS.
- 8. THE ADJUSTMENT OF ALL EXISTING APPURTENANCES SHALL BE CONSIDERED INCIDENTAL IF NOT LISTED IN THE BID SCHEDULE.
- 9. RESTORATION SHALL BE COMPLETED TO ALL PROPERTIES AFFECTED BY CONSTRUCTION ACTIVITIES AND SHALL BE CONSIDERED INCIDENTAL TO THIS PROJECT.
- 10. CONTRACTOR IS RESPONSIBLE FOR PROTECTING ALL EXISTING SURVEY MONUMENTATION. MONUMENTS DISTURBED OR DESTROYED BY CONSTRUCTION ACTIVITIES SHALL BE RESET AT NO COST TO THE CITY BY A PROFESSIONAL LAND SURVEYOR CURRENTLY REGISTERED IN THE STATE OF OREGON.
- 11. PROJECT CONTROL POINTS ESTABLISHED WITH NAVD 88.
- 12. CONTRACTOR SHALL POT HOLE ALL UTILITIES ALONG THE ALIGNMENT OF THE STORM LINE OR WATER QUALITY FACILITY PRIOR TO THE START OF CONSTRUCTION OF THE STORM LINE.
- 13. WHEN CONSTRUCTION ACTIVITIES BLOCK OR INTERFERE WITH NORMAL PEDESTRIAN ROUTING, PROVIDE SAFE PASSAGE FOR PEDESTRIANS EITHER THROUGH THE CONSTRUCTION, OR REROUTED AROUND THE CONSTRUCTION.

General Notes

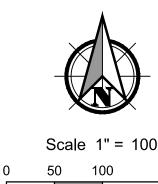OWNER: LINCOLN CITY CITY OF LINCOLN CITY 801 SW HIGHWAY 101 PO BOX 50 LINCOLN CITY, OREGON 97367

CONTACT: TERRY CHAMBERLIN, P.E. PHONE: 541.996.1292

CALL BEFORE YOU DIG! 1-800-332-2344

ATTENTION:
OREGON LAW REQUIRES YOU TO FO
UTILITY NOTIFICATION CENTER. THO

OREGON LAW REQUIRES YOU TO FOLLOW ROLES ADDOPTED BY THE OREGON UTILITY NOTIFICATION CENTER. THOSE RULES ARE SET FORTH IN OAR 952-001-0010 THROUGH OAR 952-001-0090. YOU MAY OBTAIN COPIES OF THE RULES BY CALLING THE CENTER. (NOTE: THE TELEPHONE NUMBER FOR THE OREGON UTILITY NOTIFICATION CENTER IS (503) 232-1987).



No.	Revision/Issue	Date



LINCOLN CITY PUBLIC WORKS 801 S.W. HWY 101 P.O. BOX 50 LINCOLN CITY, OREGON 97367 PHONE: (541) 996-2154 FAX: (541) 994-4881 www.lincolncity.org

Project Name and Sheet Name
SE 3RD STREET SIDEWALK

COVER SHEET

ESIGNED BY: TO

DESIGNED BY: TC PREPARED BY: PBS

Project No.:
74346.000

Date
05/15/2024

Scale
AS NOTED

EXISTING LI	NETYPE LEGEND
Existing Sanitary Sewer Pipe	ss ss ss ss
Existing Sanitary Force Main Pipe	
Existing Storm Sewer Pipe	—— SD ——— SD ——— SD ———— SD ———————————
Existing Water Pipe	
Existing Building	
Existing Centerline	
Existing Contour	
Existing Curb	
Existing Curb & Gutter	
Existing Fence	xxxxxx
Existing Gas Line	G G G G
Existing Gravel Road	
Existing Lot Line	
Existing Over Head Power Line	—— OHP ——— OHP ——— OHP ———
Existing Paint Stripe	
Existing Property Line	
Existing Right-Of-Way	
Existing Utility Easement	
Existing Wall	
Existing Shrub Line	~~~~~~~~~~~~~~~~~~~~~~~~~~~~~~~~~~~~~~~


EXISTING SYMBOL LEGEND			
Existing Catch Basin		Existing Power Pole	0
Existing Cleanout	•	Existing Monument	•
Existing Communication Riser		Existing Project Control Point	
Existing Coniferous Tree	0	Existing Sanitary Manhole	S
Existing Deciduous Tree	0	Existing Shrub	٣
Existing Electric Riser	E	Existing Sign	
Existing Fire Hydrant	₩,	Existing Storm Manhole	D
Existing Flow Arrow		Existing Street Light	← X
Existing Gas Valve	Ğ∨	Existing Water Meter	WM
Existing Guy Anchor	\rightarrow	Existing Water Valve	\bigcirc
Existing Mailbox			

Proposed Catch Basin	
Proposed Curb Inlet	
Proposed Fire Hydrant	7
Proposed Water Valve	\otimes
Proposed Water Sampling Station	
Proposed Road Sign	
Proposed Flow Arrow	1.0%
Proposed Inlet Protection Pillow	

)
ABBREVIATIONS		
Existing Ground	Е	G
Finished Ground	F	G
Top of Curb	Т	С
Bottom of Curb	В	С
Top of Back Curb	TE	3C
Bottom of Back Curb	ВЕ	3C
Top of Structure	Т	S

	PROPOSED LINETYPE LEGEND		
	Proposed Storm Pipe		
	Proposed Centerline		
	Proposed Contour	20	
	Proposed Curb		
	Proposed End of Pavement		
- % >	Proposed Erosion Control Sediment Fence/Straw Wattles	xxxxx	
	Proposed Sawcut Line		
	Proposed Score Line		
	Proposed Sidewalk		
_	Proposed Stripe		
_	Proposed Cut Line	— c — c — c — c —	
4	Proposed Fill Line	— F — F — F —	
\dashv	Proposed Metal Handrail		

HATO	CHING LEGEND
Existing Concrete Walk	
Proposed Concrete Walk	
Proposed 4" Asphalt Restoration	
Proposed New Asphalt 4" Asphalt Over 12" Base	
Proposed Asphalt Grind And Overlay To Existing	
Proposed Asphalt Transition	
Proposed 2" Min. Asphalt Overlay	
Proposed Asphalt Walk	
Hydroseed	\ \ \ \ \ \ \ \ \ \ \ \ \ \ \ \ \ \ \
WQ Seed Mix	* * * * * * * * * * * * * * * * * * *
Fill Slopes	+ + + + + + + + + + + + + + + + + + +
Cut Slopes	
Truncated Domes	
Gravel	
Rock Fill Slope	
Outfall Rip Rap	

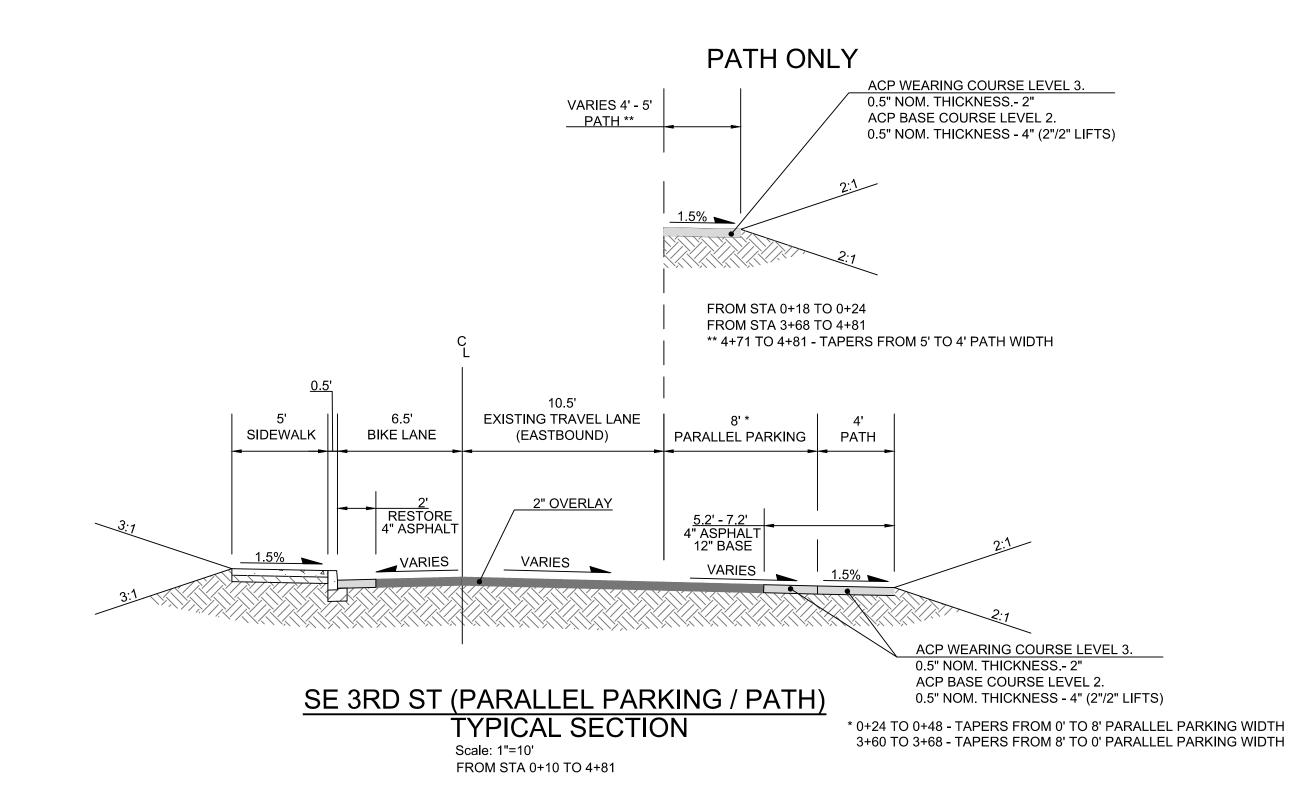

EXISTING EDGE OF PAVEMENT SIDEWALK TRAVEL LANE TRAVEL LANE SIDEWALK PER DETAIL VARIES VARIES TYPICAL CURB PER DETAIL PROFILE CONTROL POINT AGGR. BASE NOM. THICKNESS 12" 2" OVERLAY SE 3RD ST (TWO-WAY TRAFFIC)

TYPICAL SECTION

Scale: 1"=10'

FROM STA 4+81 TO 7+13 FROM STA 10+11 TO 21+98 FROM STA 30+33 TO 31+75 **General Notes**

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Project Name and Sheet Name SE 3RD STREET SIDEWALK

801 S.W. HWY 101

PHONE: (541) 996-2154 FAX: (541) 994-4881 www.lincolncity.org

LINCOLN CITY, OREGON 97367

P.O. BOX 50

LEGEND & TYPICAL SECTIONS C-002

DESIGNED BY: TC PREPARED BY: PBS

74346.000

05/15/2024

IF LESS THAN FULL SIZE, NTS

AS NOTED

Sheet No.

